














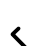












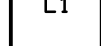
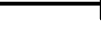
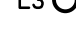






LEGEND

-  ELECTRICAL SERVICES SWITCHBOARD.
-  SWITCHBOARD / CONTROL PANEL NOT PROVIDED AS PART OF THE ELECTRICAL SUBCONTRACT.
-  SINGLE POWER OUTLET.
-  DOUBLE POWER OUTLET.
-  SPECIAL PURPOSE POWER OUTLET.
-  SINGLE PHASE ISOLATOR.
-  THREE PHASE ISOLATOR.
-  JUNCTION BOX.
-  CONDUIT ROUTE.
-  x DENOTES CONDUIT TYPE.
-  PIT x □ ELECTRICAL PIT, TYPE AS NOTED.
-  TELSTRA PIT.
-  LIGHTING PRESENCE DETECTOR SWITCH.
-  LIGHTING CONTROL SWITCH PANEL.
-  ONE-WAY LIGHT SWITCH.
-  TWO-WAY LIGHT SWITCH.
-  ONE-WAY LIGHT SWITCH C/W DIMMER.
-  CIRCUIT LINE.
-  SWITCH LINE.
-  DB-x - Py POWER CIRCUIT DESIGNATION. DENOTES DB AND CIRCUIT.
-  ELECTRICAL EQUIPMENT AS NOTED.
-  RJ45 COMMUNICATIONS OUTLET.
-  SECURITY DIRECTIONAL MOTION DETECTOR.
-  PA MULTI-TAP CONE SPEAKER.
-  REFER TO DETAIL NOTED FOR THE AREA SHOWN HATCHED. ADDITIONAL OUTLETS & FITTINGS MAY BE SHOWN ON DETAIL.
-  E1: GENERAL LED EMERGENCY LIGHT.
-  EX: EMERGENCY LED EXIT LIGHT.
-  Lx: LIGHT FITTING C/W NON-MAINTAINED EMERGENCY BATTERY PACK. TYPE AS NOTED.
-  L1: 600 x 600 LED FLAT PANEL T-BAR FITTING.
-  L2: 1200 LONG LED SURFACE BATTEN.
-  L3: RECESSED DOWNLIGHT.
-  L4: OVERHEAD CUPBOARD LED STRIP LIGHT.
-  L5: RECESSED DOWNLIGHT.
-  L6: L1: 600 x 600 LED FLAT PANEL T-BAR FITTING.

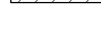NOTE

ALL ELECTRICAL PENETRATIONS THROUGH THE ROOF SHEETING ARE TO BE IN LINE WITH THE STRUCTURAL OR MECHANICAL SERVICES PENETRATIONS TO AVOID DEDICATED FLASHINGS FOR THE ELECTRICAL SERVICES.

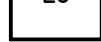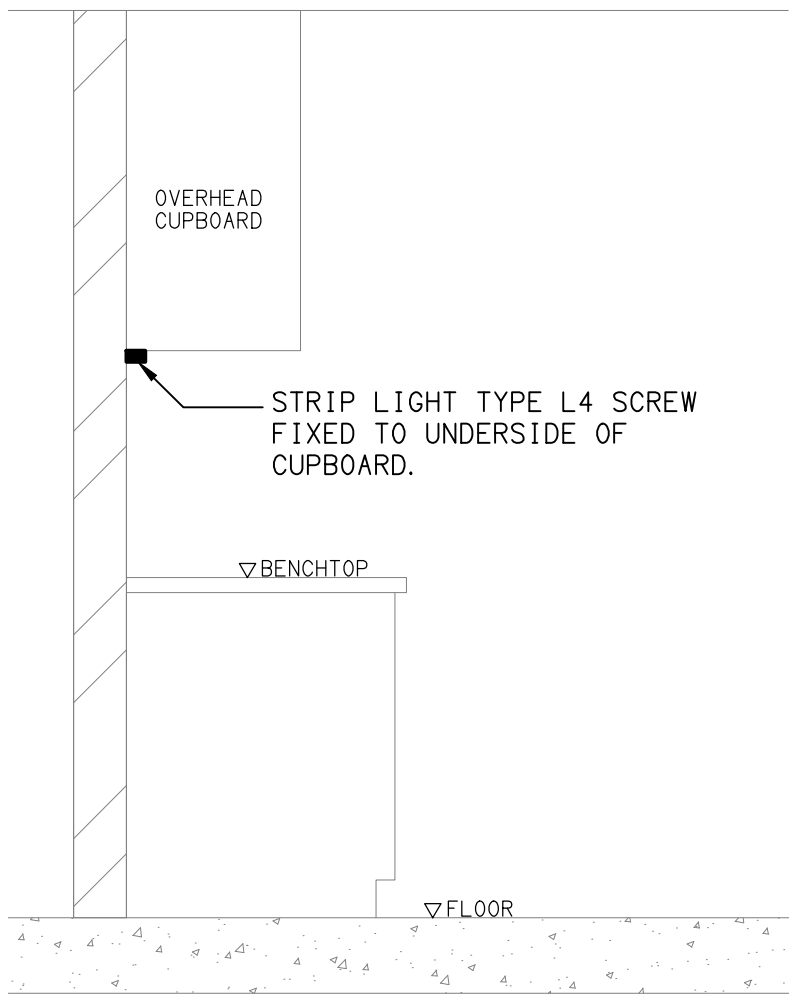


DETAIL

"L4" TYPE STRIP LIGHT MOUNTING  
NOT TO SCALE

EQUIPMENT:

- TEST - TEST PUSH BUTTON MOUNTED ON THE DISTRIBUTION BOARD ESCUTCHEON.
- RESET - RESET PUSH BUTTON MOUNTED ON THE DISTRIBUTION BOARD ESCUTCHEON.
- LAMP - AMBER TEST INDICATING LAMP MOUNTED ON THE DISTRIBUTION BOARD ESCUTCHEON.
- Ta - ADJUSTABLE 0-3 HOUR TIMED RELAY.
- Tb - 15 MINUTE RUN-ON TIMER TO OPERATE UPON THE RETURN OF MAINS POWER.
- Cx - CONTACTOR x.
- CRx - CONTROL RELAY x.
- Rx - RELAY x.

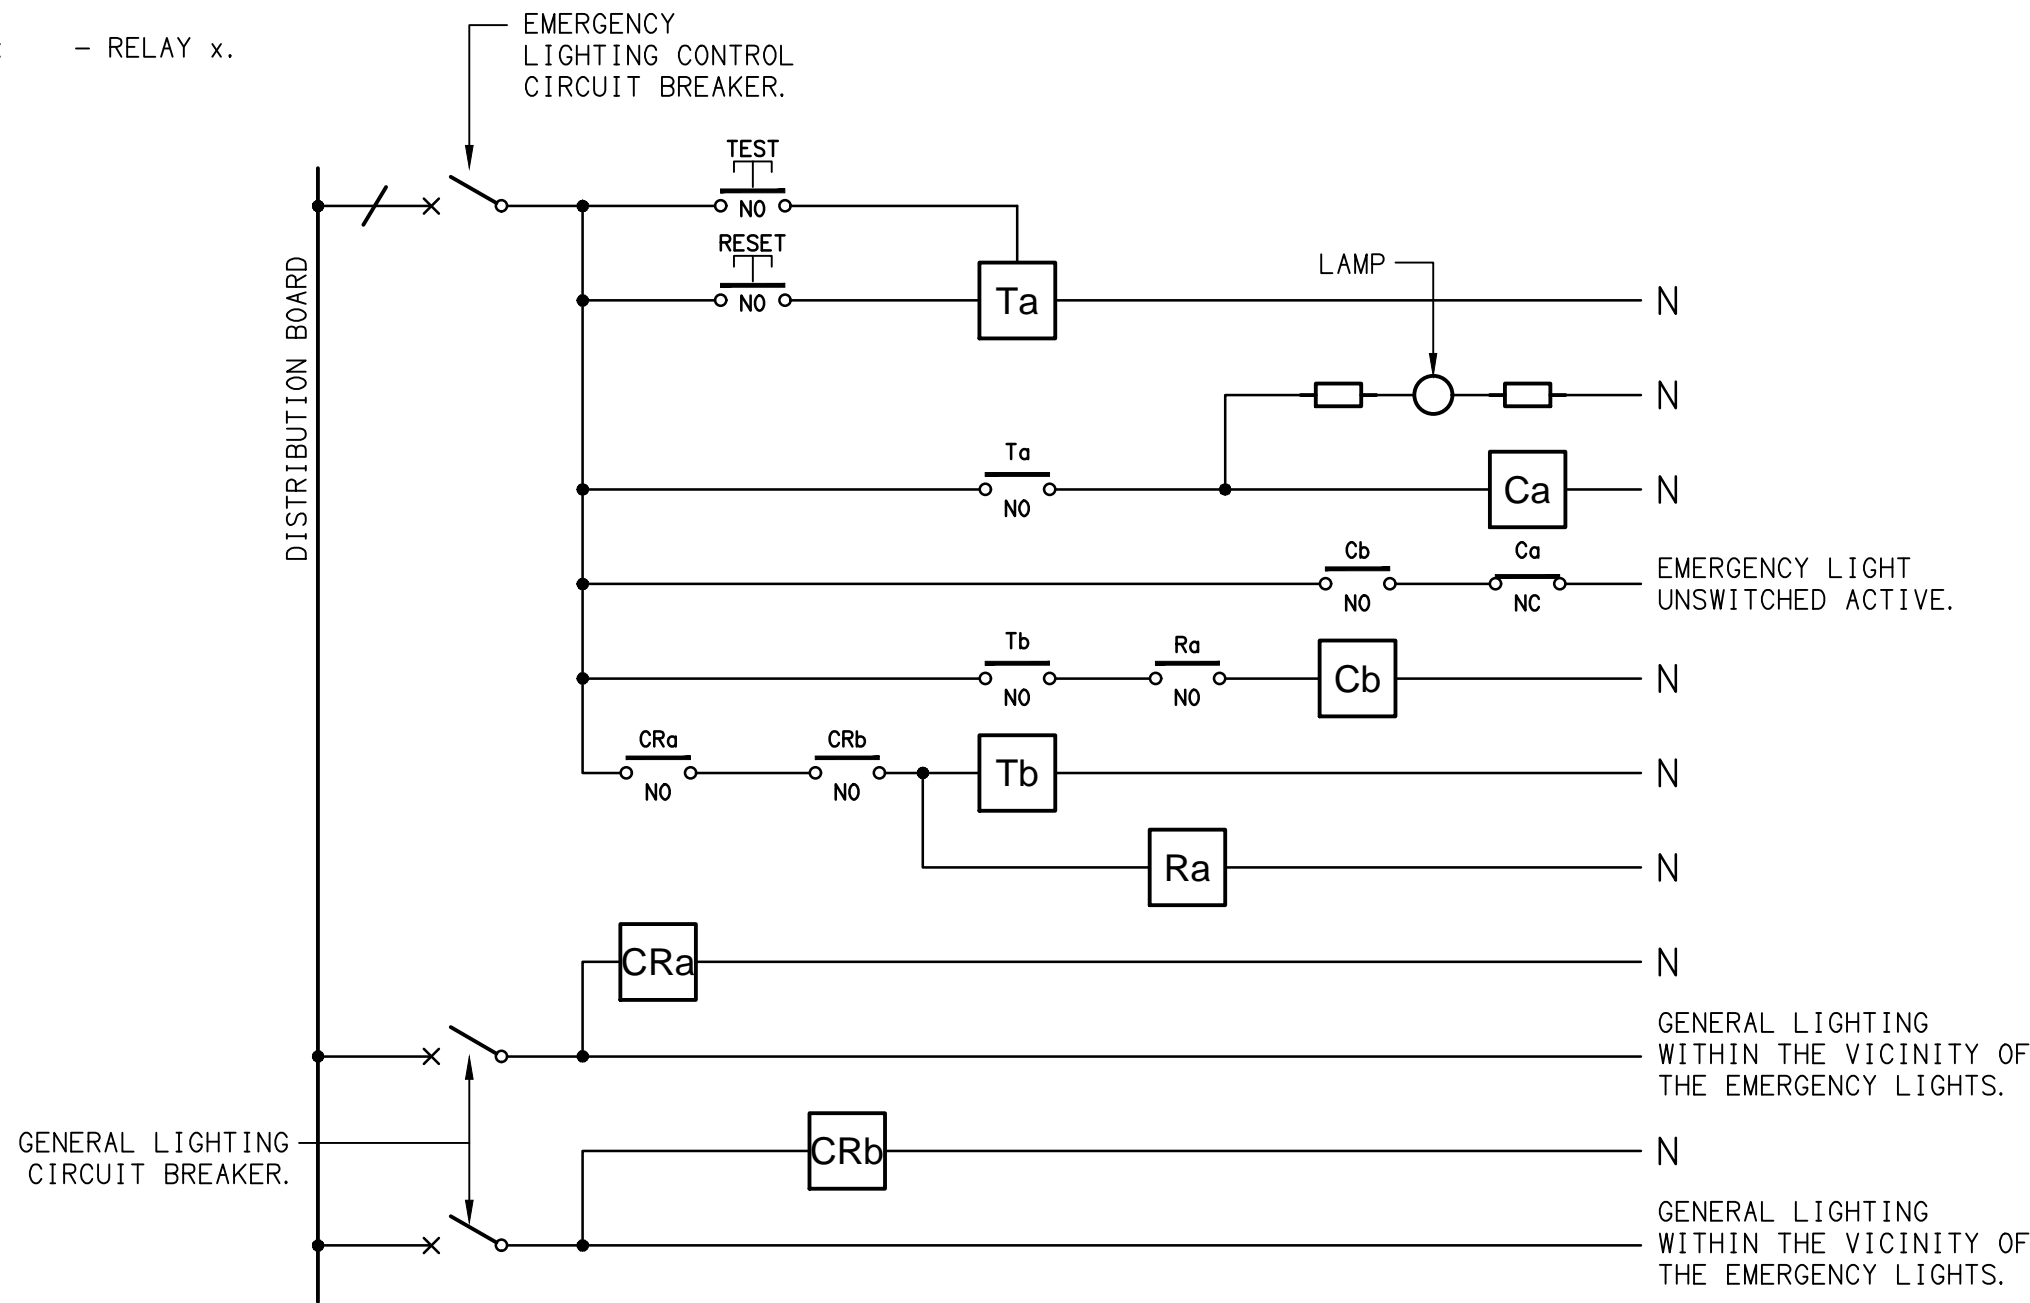


NOTES

1. THE EMERGENCY LIGHT UNSWITCHED ACTIVE / GENERAL LIGHTING SWITCHED ACTIVE CIRCUIT ARRANGEMENT AND CONTROL IS TYPICAL FOR ALL CIRCUITS SUPPLYING EMERGENCY LIGHTS.
2. PROVIDE ADDITIONAL CONTROL RELAYS (CRx) CONFIGURED AS PER CRa AND CRb FOR ALL ADDITIONAL LIGHTING CIRCUITS THAT SUPPLY LIGHTS IN THE VICINITY OF THE EMERGENCY LIGHTS.


SCHEMATIC

EMERGENCY LIGHTING  
NOT TO SCALE

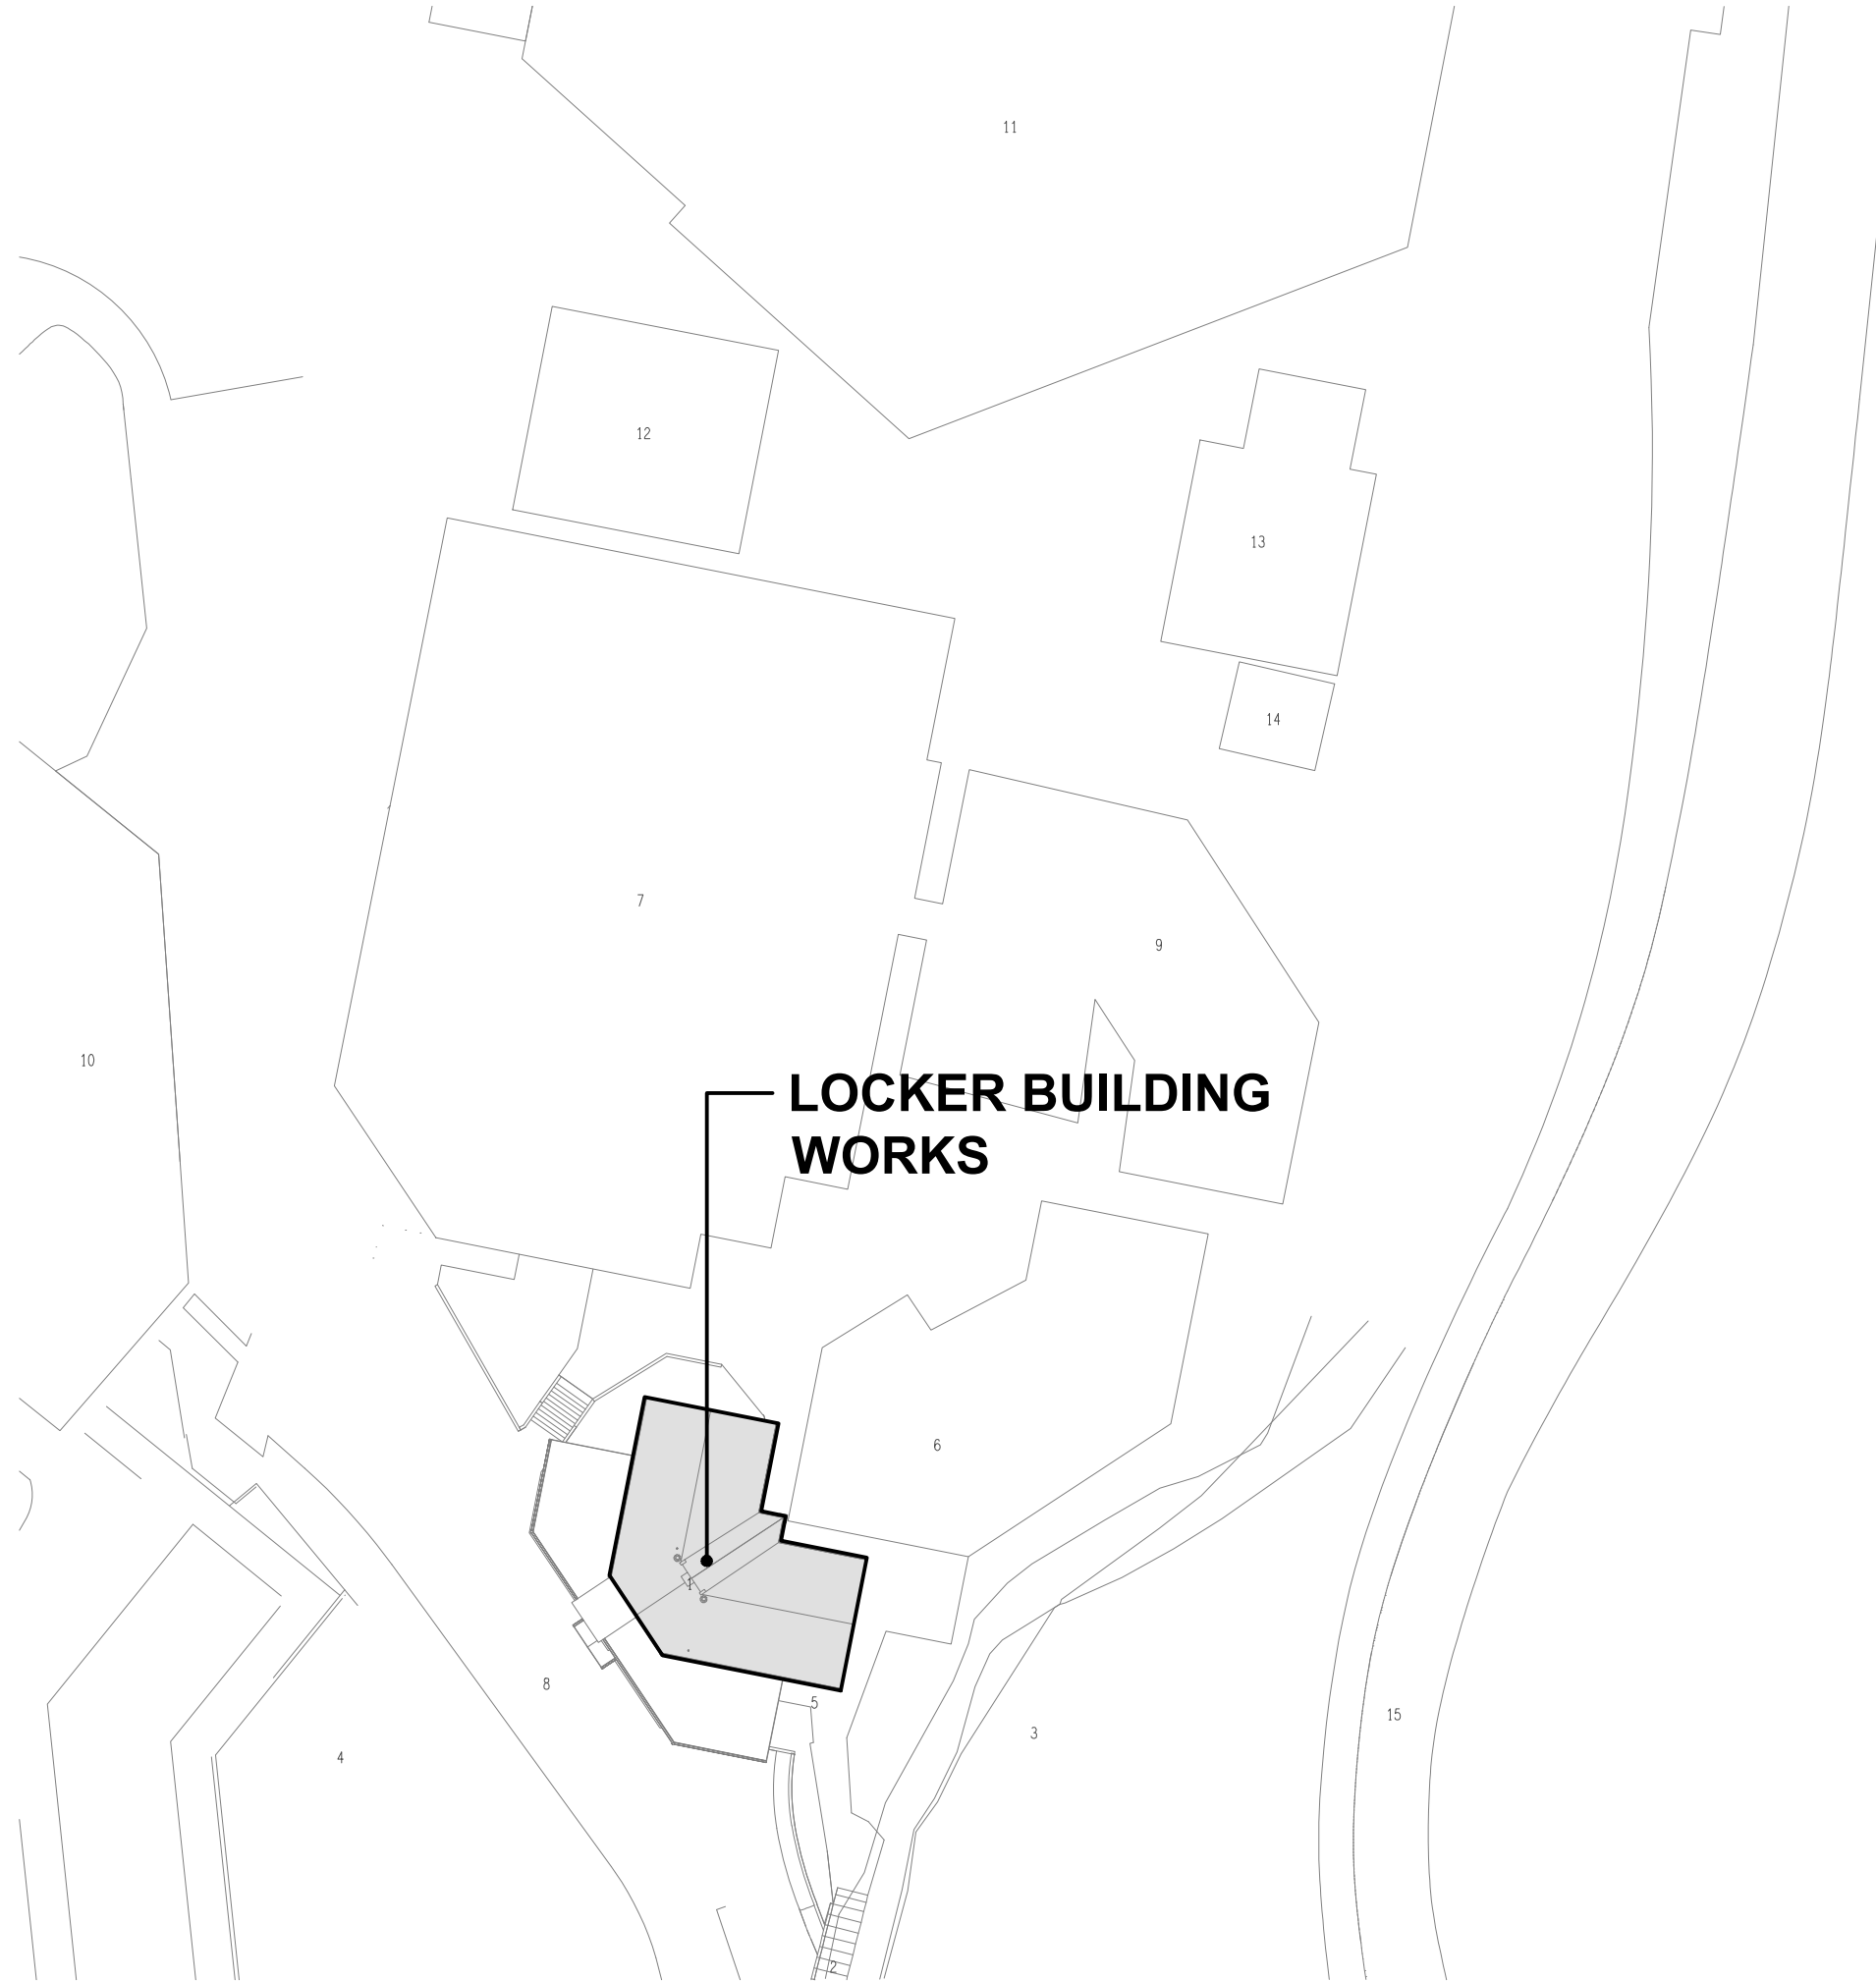

SITE PLAN

LOCKER BUILDING WORKS  
SCALE 1:500

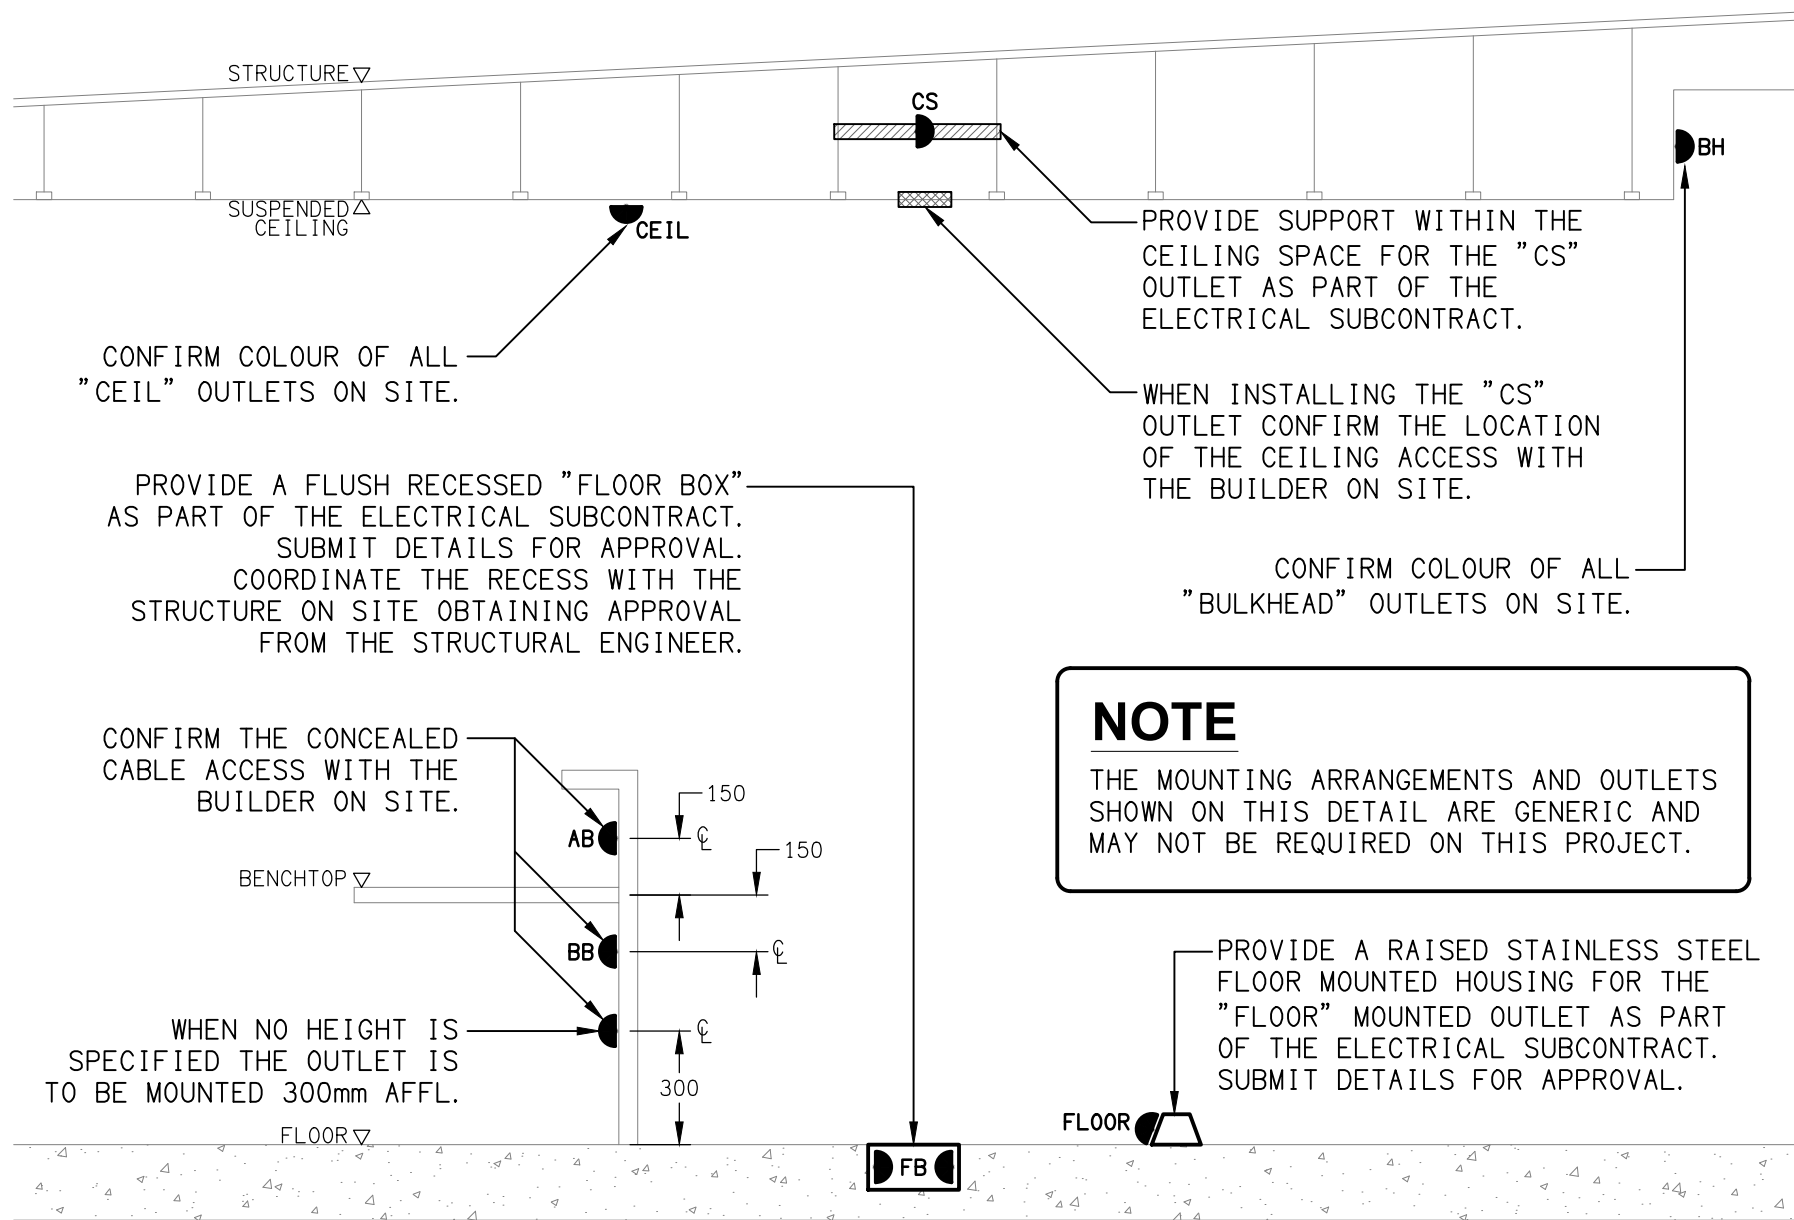

DETAIL

TYPICAL OUTLET MOUNTINGS  
NOT TO SCALE

<div>ELECTRICAL DESIGN GROUP BRISBANE PTY LTD ACN 092 710 793</div> <div>TRADING AS: ELECTRICAL DESIGN GROUP</div>	THE COPYRIGHT OF THIS DRAWING REMAINS THE PROPERTY OF THE ELECTRICAL DESIGN GROUP.	<div> <b>ELECTRICAL DESIGN GROUP</b></div> <div>ELECTRICAL BUILDING SERVICES CONSULTANTS</div> <div>BRISBANE GOLD COAST</div> <div>P.O.Box 15, Sherwood Q.4075 Phone: (07) 3278 4375 Email: brisbane@edg.net.au Web: www.edg.net.au</div>	PROJECT: <b>CITIPOINTE - LOCKER BUILDING</b>	DRAWING: <b>ELECTRICAL SERVICES LEGEND &amp; SITE PLAN</b>			
	USE FIGURED DIMENSIONS IN PREFERENCE TO SCALE.						
	ALL DIMENSIONS TO BE VERIFIED ONSITE.			322 WECKER ROAD, CARINDALE	SCALE: 1:500	AT A1	
					PROJECT NO: <b>C3548a</b>	DRAWING NO: <b>E01</b>	REVISION: <b>A</b>